

KEY PLAN SCALE 1" = 600'

DRAWING REVISIONS REVISION DRAWING RELEASE DATE ISSUE

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ENGINEER:

▽H.BYE ▽ MOUNT FOREST 519-323-1527 Since 2017


H.BYE

LEGEND SHORT STANDARD IRON BAR SSIB STANDARD IRON BAR

PROPERTY BOUNDARY LINE PROPOSED REZONING AREA
BOUNDARY LINE
EXISTING CONTOUR LINE
(ELEVATIONS ARE IN METERS)


CONSTRUCTION BY: H.BYE PROJECT NAME / LOCATION: VIKING & YARDISTRY DEVELOPMENT


TOPOGRAPHIC SURVEY SCALE 1"=150'

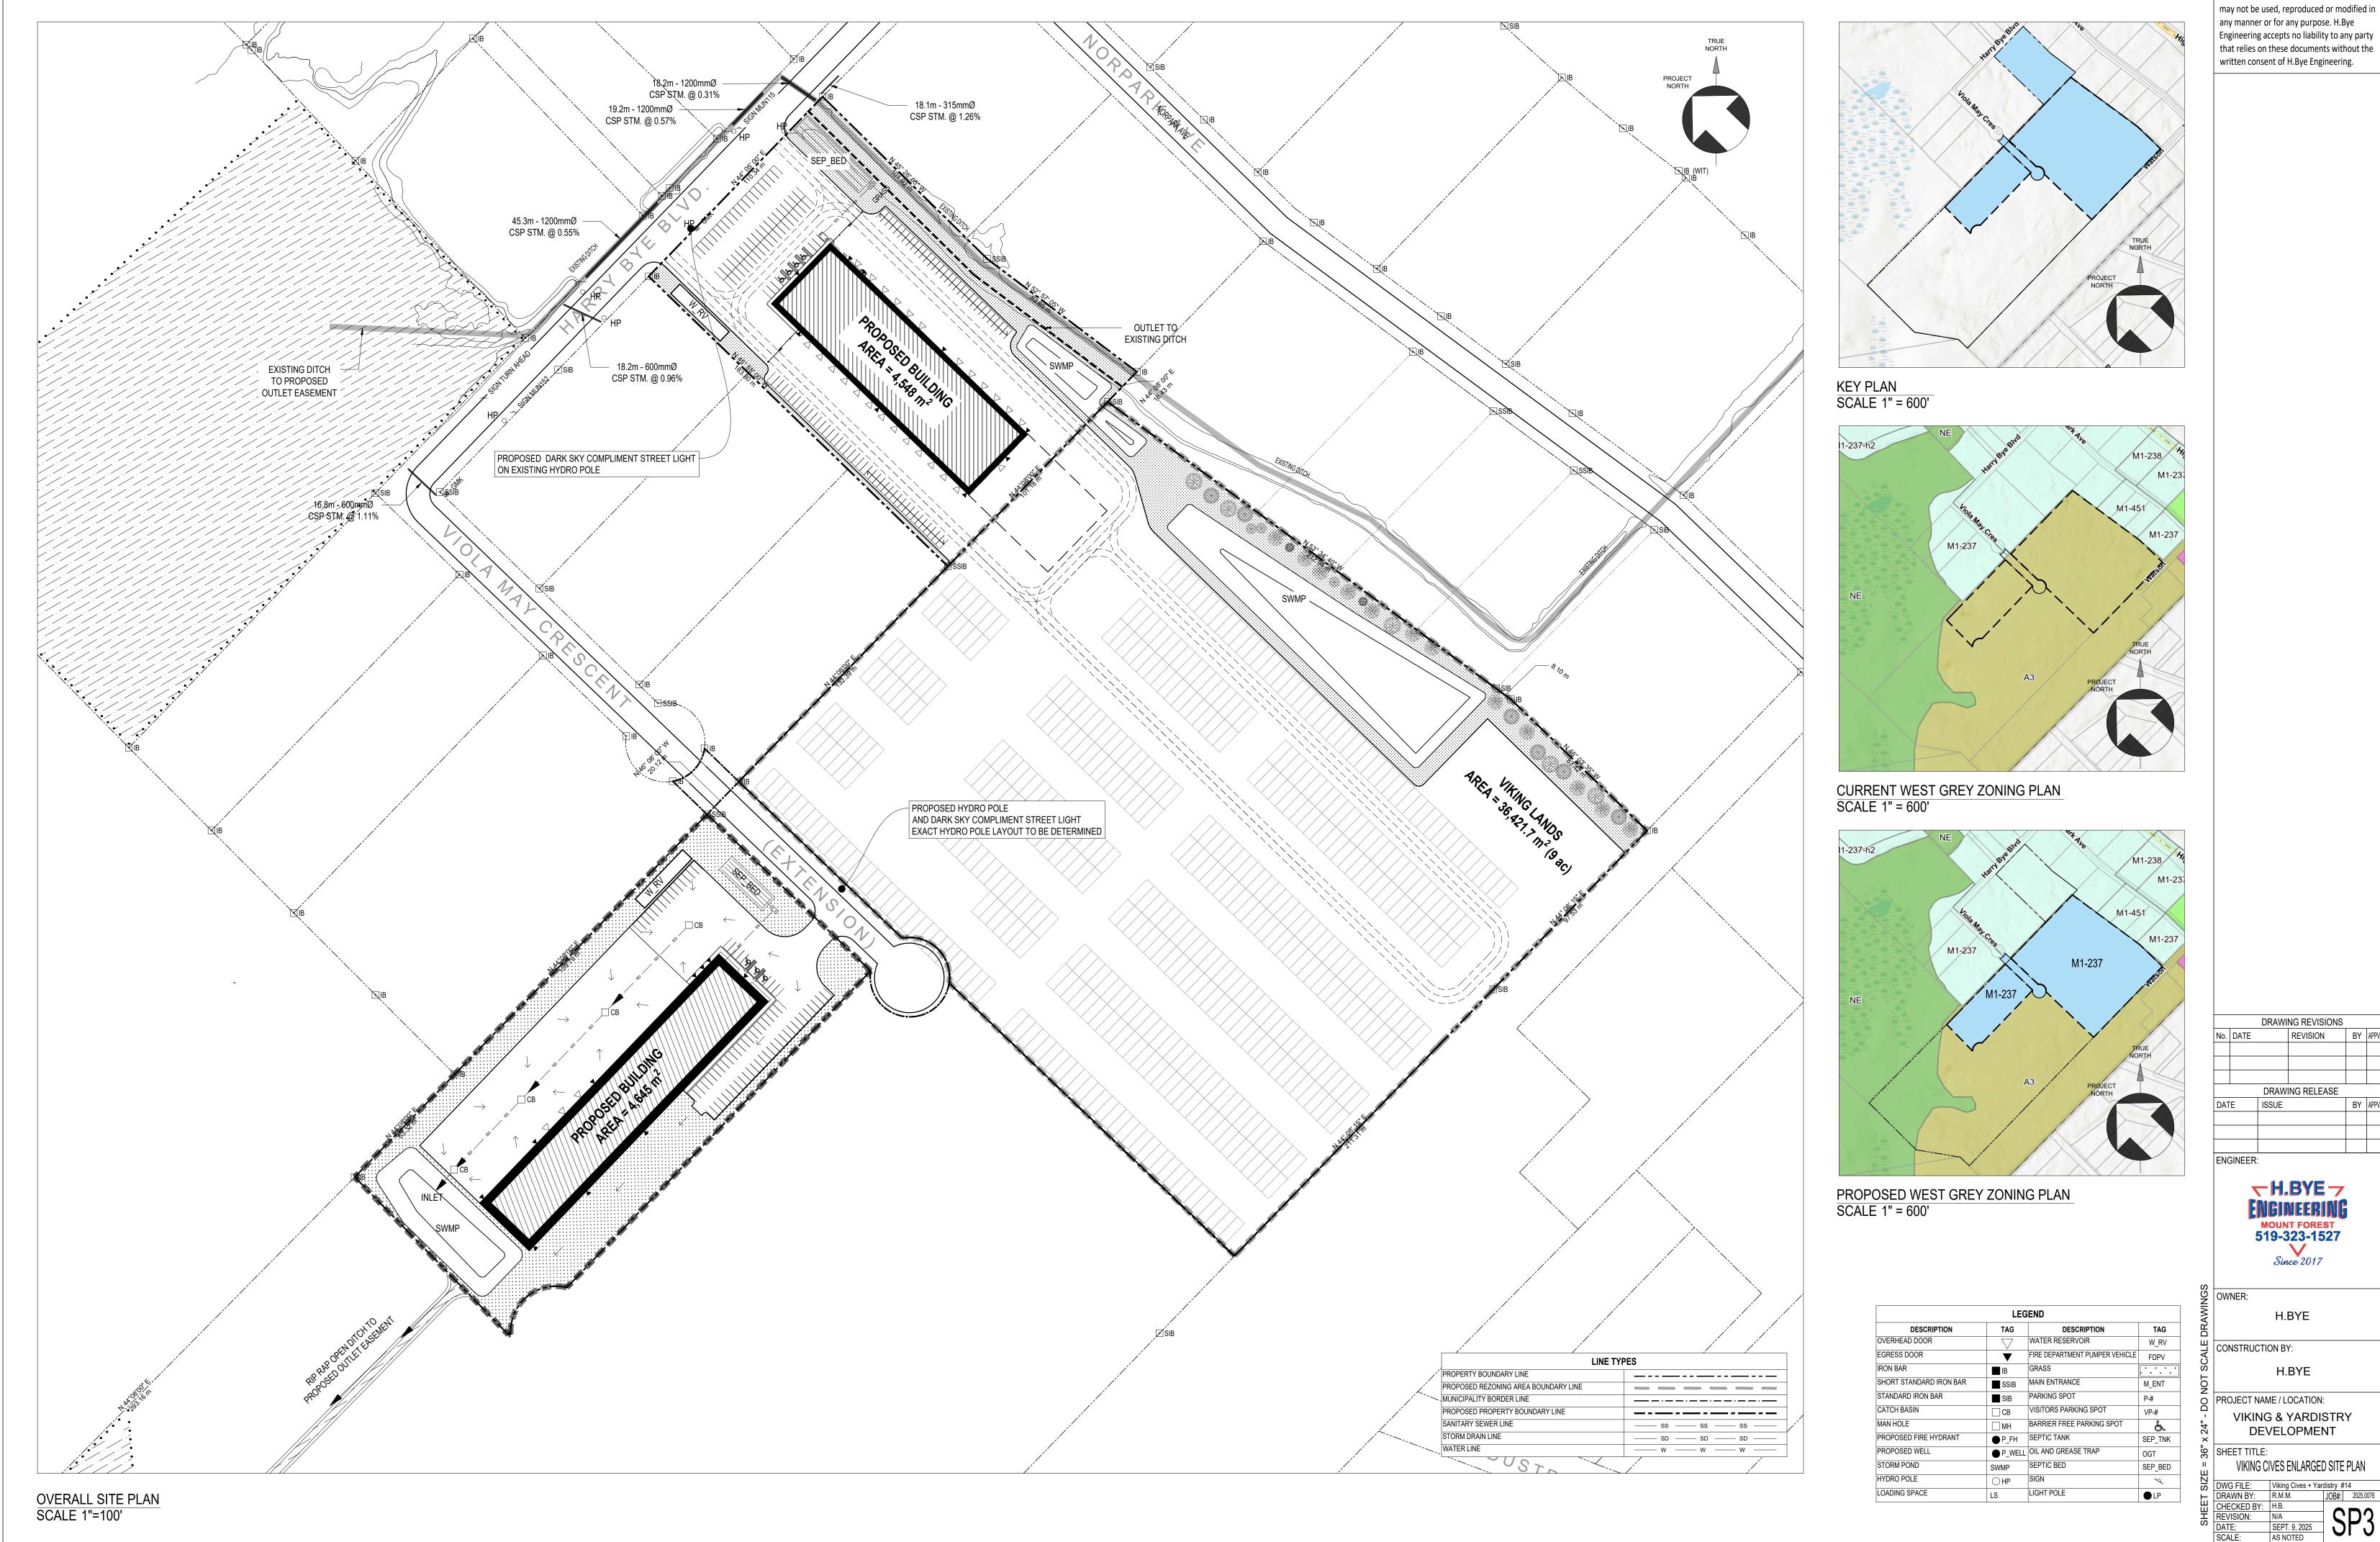

This document and all associated documents

REVISION BY APPVD

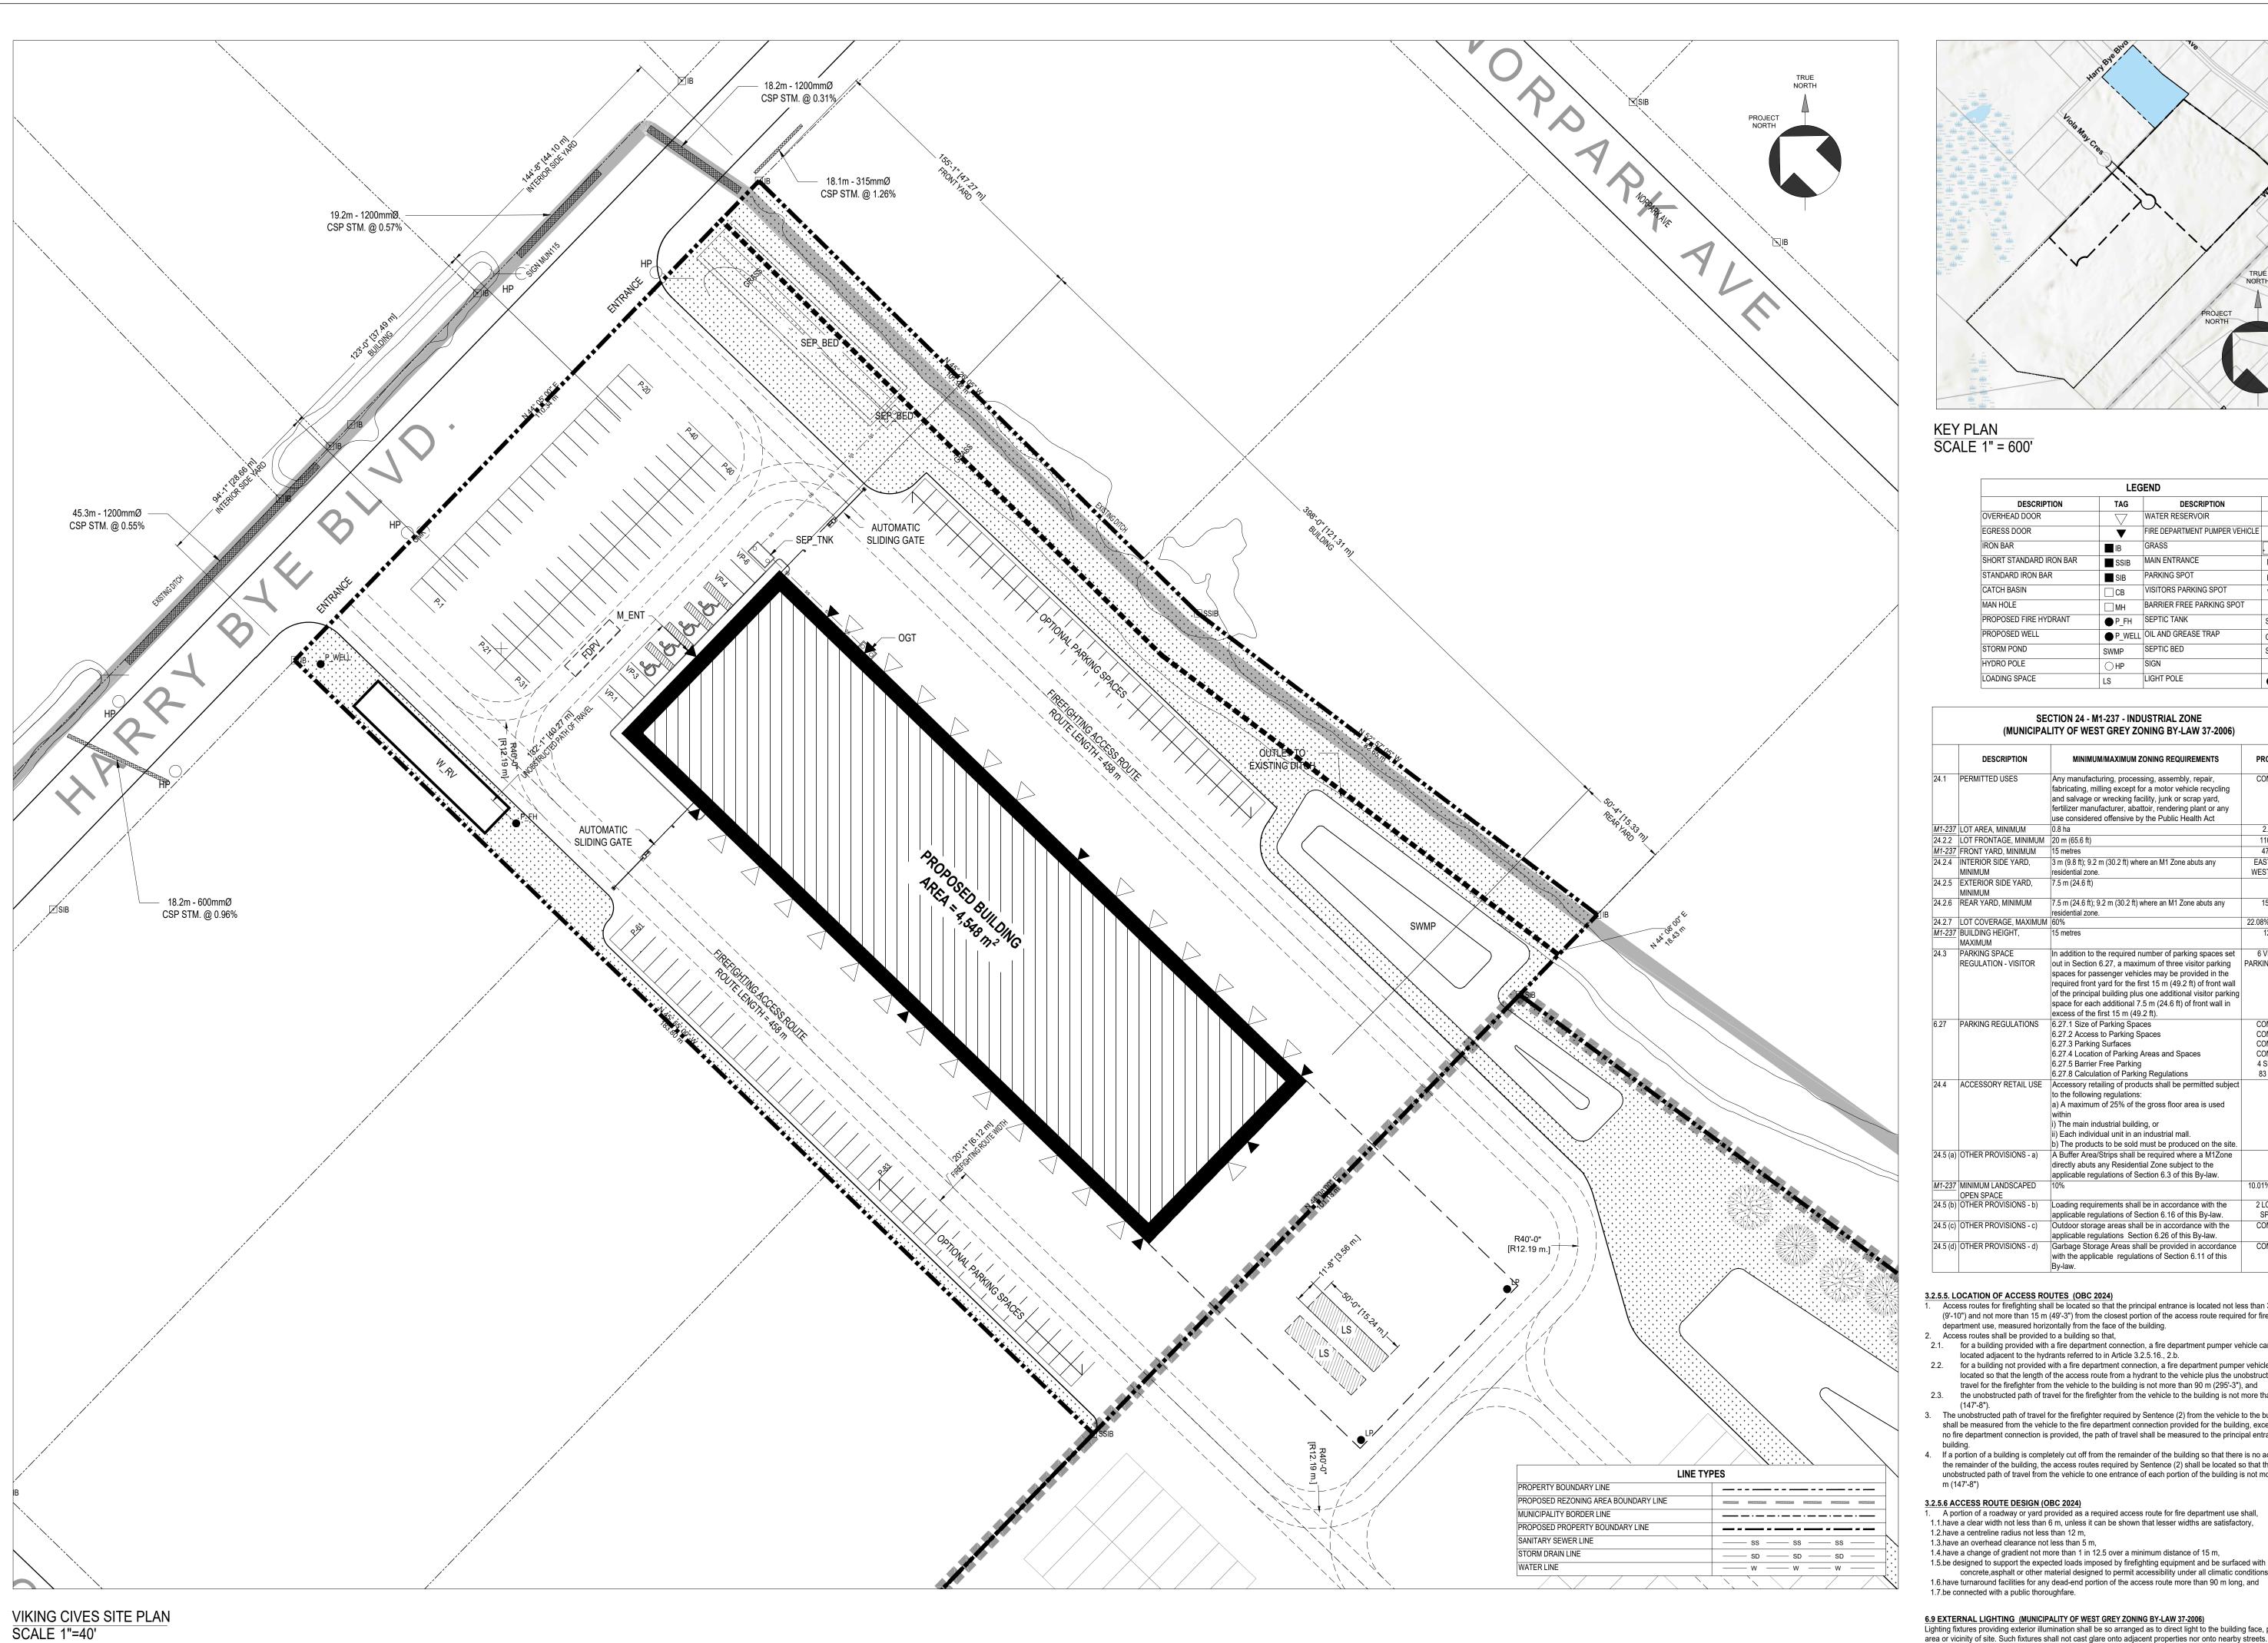

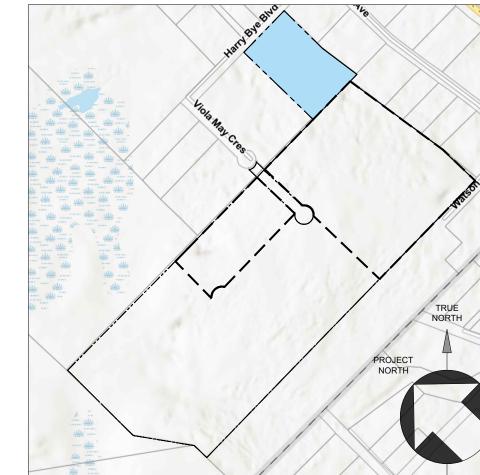

KEY PLAN SCALE 1" = 600'

	LEG	END	
DESCRIPTION	TAG	DESCRIPTION	TAG
OVERHEAD DOOR	$\overline{}$	WATER RESERVOIR	W_RV
EGRESS DOOR	▼	FIRE DEPARTMENT PUMPER VEHICLE	FDPV
IRON BAR	■ IB	GRASS	* * * *
SHORT STANDARD IRON BAR	SSIB	MAIN ENTRANCE	M_ENT
STANDARD IRON BAR	■ SIB	PARKING SPOT	P-#
CATCH BASIN	СВ	VISITORS PARKING SPOT	VP-#
MAN HOLE	МН	BARRIER FREE PARKING SPOT	Ġ.
PROPOSED FIRE HYDRANT	● P_FH	SEPTIC TANK	SEP_TNK
PROPOSED WELL	● P_WELL	OIL AND GREASE TRAP	OGT
STORM POND	SWMP	SEPTIC BED	SEP_BED
HYDRO POLE	○HP	SIGN	8
LOADING SPACE	LS	LIGHT POLE	● LP

	·	SECTION 24 - M1-237 - INDUSTRIAL ZONE (MUNICIPALITY OF WEST GREY ZONING BY-LAW 37-2006)			
	DESCRIPTION	MINIMUM/MAXIMUM ZONING REQUIREMENTS	PROVIDED		
24.1	PERMITTED USES	Any manufacturing, processing, assembly, repair, fabricating, milling except for a motor vehicle recycling and salvage or wrecking facility, junk or scrap yard, fertilizer manufacturer, abattoir, rendering plant or any use considered offensive by the Public Health Act	COMPLIES		
	LOT AREA, MINIMUM	0.8 ha	2.06 ha		
24.2.2	LOT FRONTAGE, MINIMUM	20 m (65.6 ft)	110.34 m		
M1-237	FRONT YARD, MINIMUM	15 metres	47.27 m		
24.2.4	INTERIOR SIDE YARD, MINIMUM	3 m (9.8 ft); 9.2 m (30.2 ft) where an M1 Zone abuts any residential zone.	EAST 44.1 m WEST 28.66 m		
	EXTERIOR SIDE YARD, MINIMUM	7.5 m (24.6 ft)	N/A		
24.2.6	REAR YARD, MINIMUM	7.5 m (24.6 ft); 9.2 m (30.2 ft) where an M1 Zone abuts any residential zone.	15.33 m		
	LOT COVERAGE, MAXIMUM	60%	22.08% (4,548m ²		
M1-237	BUILDING HEIGHT, MAXIMUM	15 metres	12.2 m		
24.3	PARKING SPACE REGULATION - VISITOR	In addition to the required number of parking spaces set out in Section 6.27, a maximum of three visitor parking spaces for passenger vehicles may be provided in the required front yard for the first 15 m (49.2 ft) of front wall of the principal building plus one additional visitor parking space for each additional 7.5 m (24.6 ft) of front wall in excess of the first 15 m (49.2 ft).	6 VISITOR PARKING SPACE		
6.27	PARKING REGULATIONS	6.27.1 Size of Parking Spaces 6.27.2 Access to Parking Spaces 6.27.3 Parking Surfaces 6.27.4 Location of Parking Areas and Spaces 6.27.5 Barrier Free Parking 6.27.8 Calculation of Parking Regulations	COMPLIES COMPLIES COMPLIES COMPLIES 4 SPACES 83 SPACES		
24.4	ACCESSORY RETAIL USE	Accessory retailing of products shall be permitted subject to the following regulations: a) A maximum of 25% of the gross floor area is used within i) The main industrial building, or ii) Each individual unit in an industrial mall. b) The products to be sold must be produced on the site.	N/A		
24.5 (a)	OTHER PROVISIONS - a)	A Buffer Area/Strips shall be required where a M1Zone directly abuts any Residential Zone subject to the applicable regulations of Section 6.3 of this By-law.	N/A		
M1-237	MINIMUM LANDSCAPED OPEN SPACE	10%	10.01% (0.96 ha)		
24.5 (b)	OTHER PROVISIONS - b)	Loading requirements shall be in accordance with the applicable regulations of Section 6.16 of this By-law.	2 LOADING SPACES		
24.5 (c)	OTHER PROVISIONS - c)	Outdoor storage areas shall be in accordance with the applicable regulations Section 6.26 of this By-law.	COMPLIES		
24.5 (d)	OTHER PROVISIONS - d)	Garbage Storage Areas shall be provided in accordance with the applicable regulations of Section 6.11 of this By-law.	COMPLIES		
		I			

3.2.5.5. LOCATION OF ACCESS ROUTES (OBC 2024)

- Access routes for firefighting shall be located so that the principal entrance is located not less than 3 m (9'-10") and not more than 15 m (49'-3") from the closest portion of the access route required for fire department use, measured horizontally from the face of the building.
- Access routes shall be provided to a building so that, 2.1. for a building provided with a fire department connection, a fire department pumper vehicle can be located adjacent to the hydrants referred to in Article 3.2.5.16., 2.b.
- 2.2. for a building not provided with a fire department connection, a fire department pumper vehicle can be located so that the length of the access route from a hydrant to the vehicle plus the unobstructed path of travel for the firefighter from the vehicle to the building is not more than 90 m (295'-3"), and
 2.3. the unobstructed path of travel for the firefighter from the vehicle to the building is not more than 45 m
- 3. The unobstructed path of travel for the firefighter required by Sentence (2) from the vehicle to the building shall be measured from the vehicle to the fire department connection provided for the building, except that if no fire department connection is provided, the path of travel shall be measured to the principal entrance of the
- 4. If a portion of a building is completely cut off from the remainder of the building so that there is no access to the remainder of the building, the access routes required by Sentence (2) shall be located so that the unobstructed path of travel from the vehicle to one entrance of each portion of the building is not more than 45

3.2.5.6 ACCESS ROUTE DESIGN (OBC 2024)


- A portion of a roadway or yard provided as a required access route for fire department use shall, 1.1.have a clear width not less than 6 m, unless it can be shown that lesser widths are satisfactory, 1.2.have a centreline radius not less than 12 m,
- 1.3.have an overhead clearance not less than 5 m, 1.4.have a change of gradient not more than 1 in 12.5 over a minimum distance of 15 m, 1.5.be designed to support the expected loads imposed by firefighting equipment and be surfaced with concrete, asphalt or other material designed to permit accessibility under all climatic conditions,

6.9 EXTERNAL LIGHTING (MUNICIPALITY OF WEST GREY ZONING BY-LAW 37-2006)

Lighting fixtures providing exterior illumination shall be so arranged as to direct light to the building face, parking area or vicinity of site. Such fixtures shall not cast glare onto adjacent properties nor onto nearby streets.

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CONSTRUCTION BY:

SHEET TITLE:

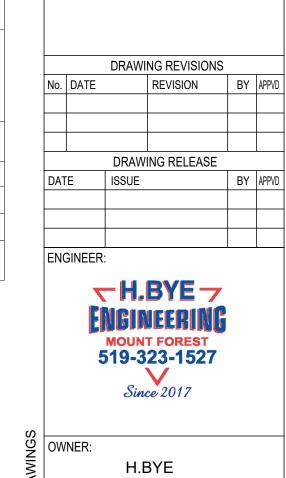
PROJECT NAME / LOCATION:

H.BYE

VIKING & YARDISTRY

DEVELOPMENT

VIKING CIVES SITE PLAN

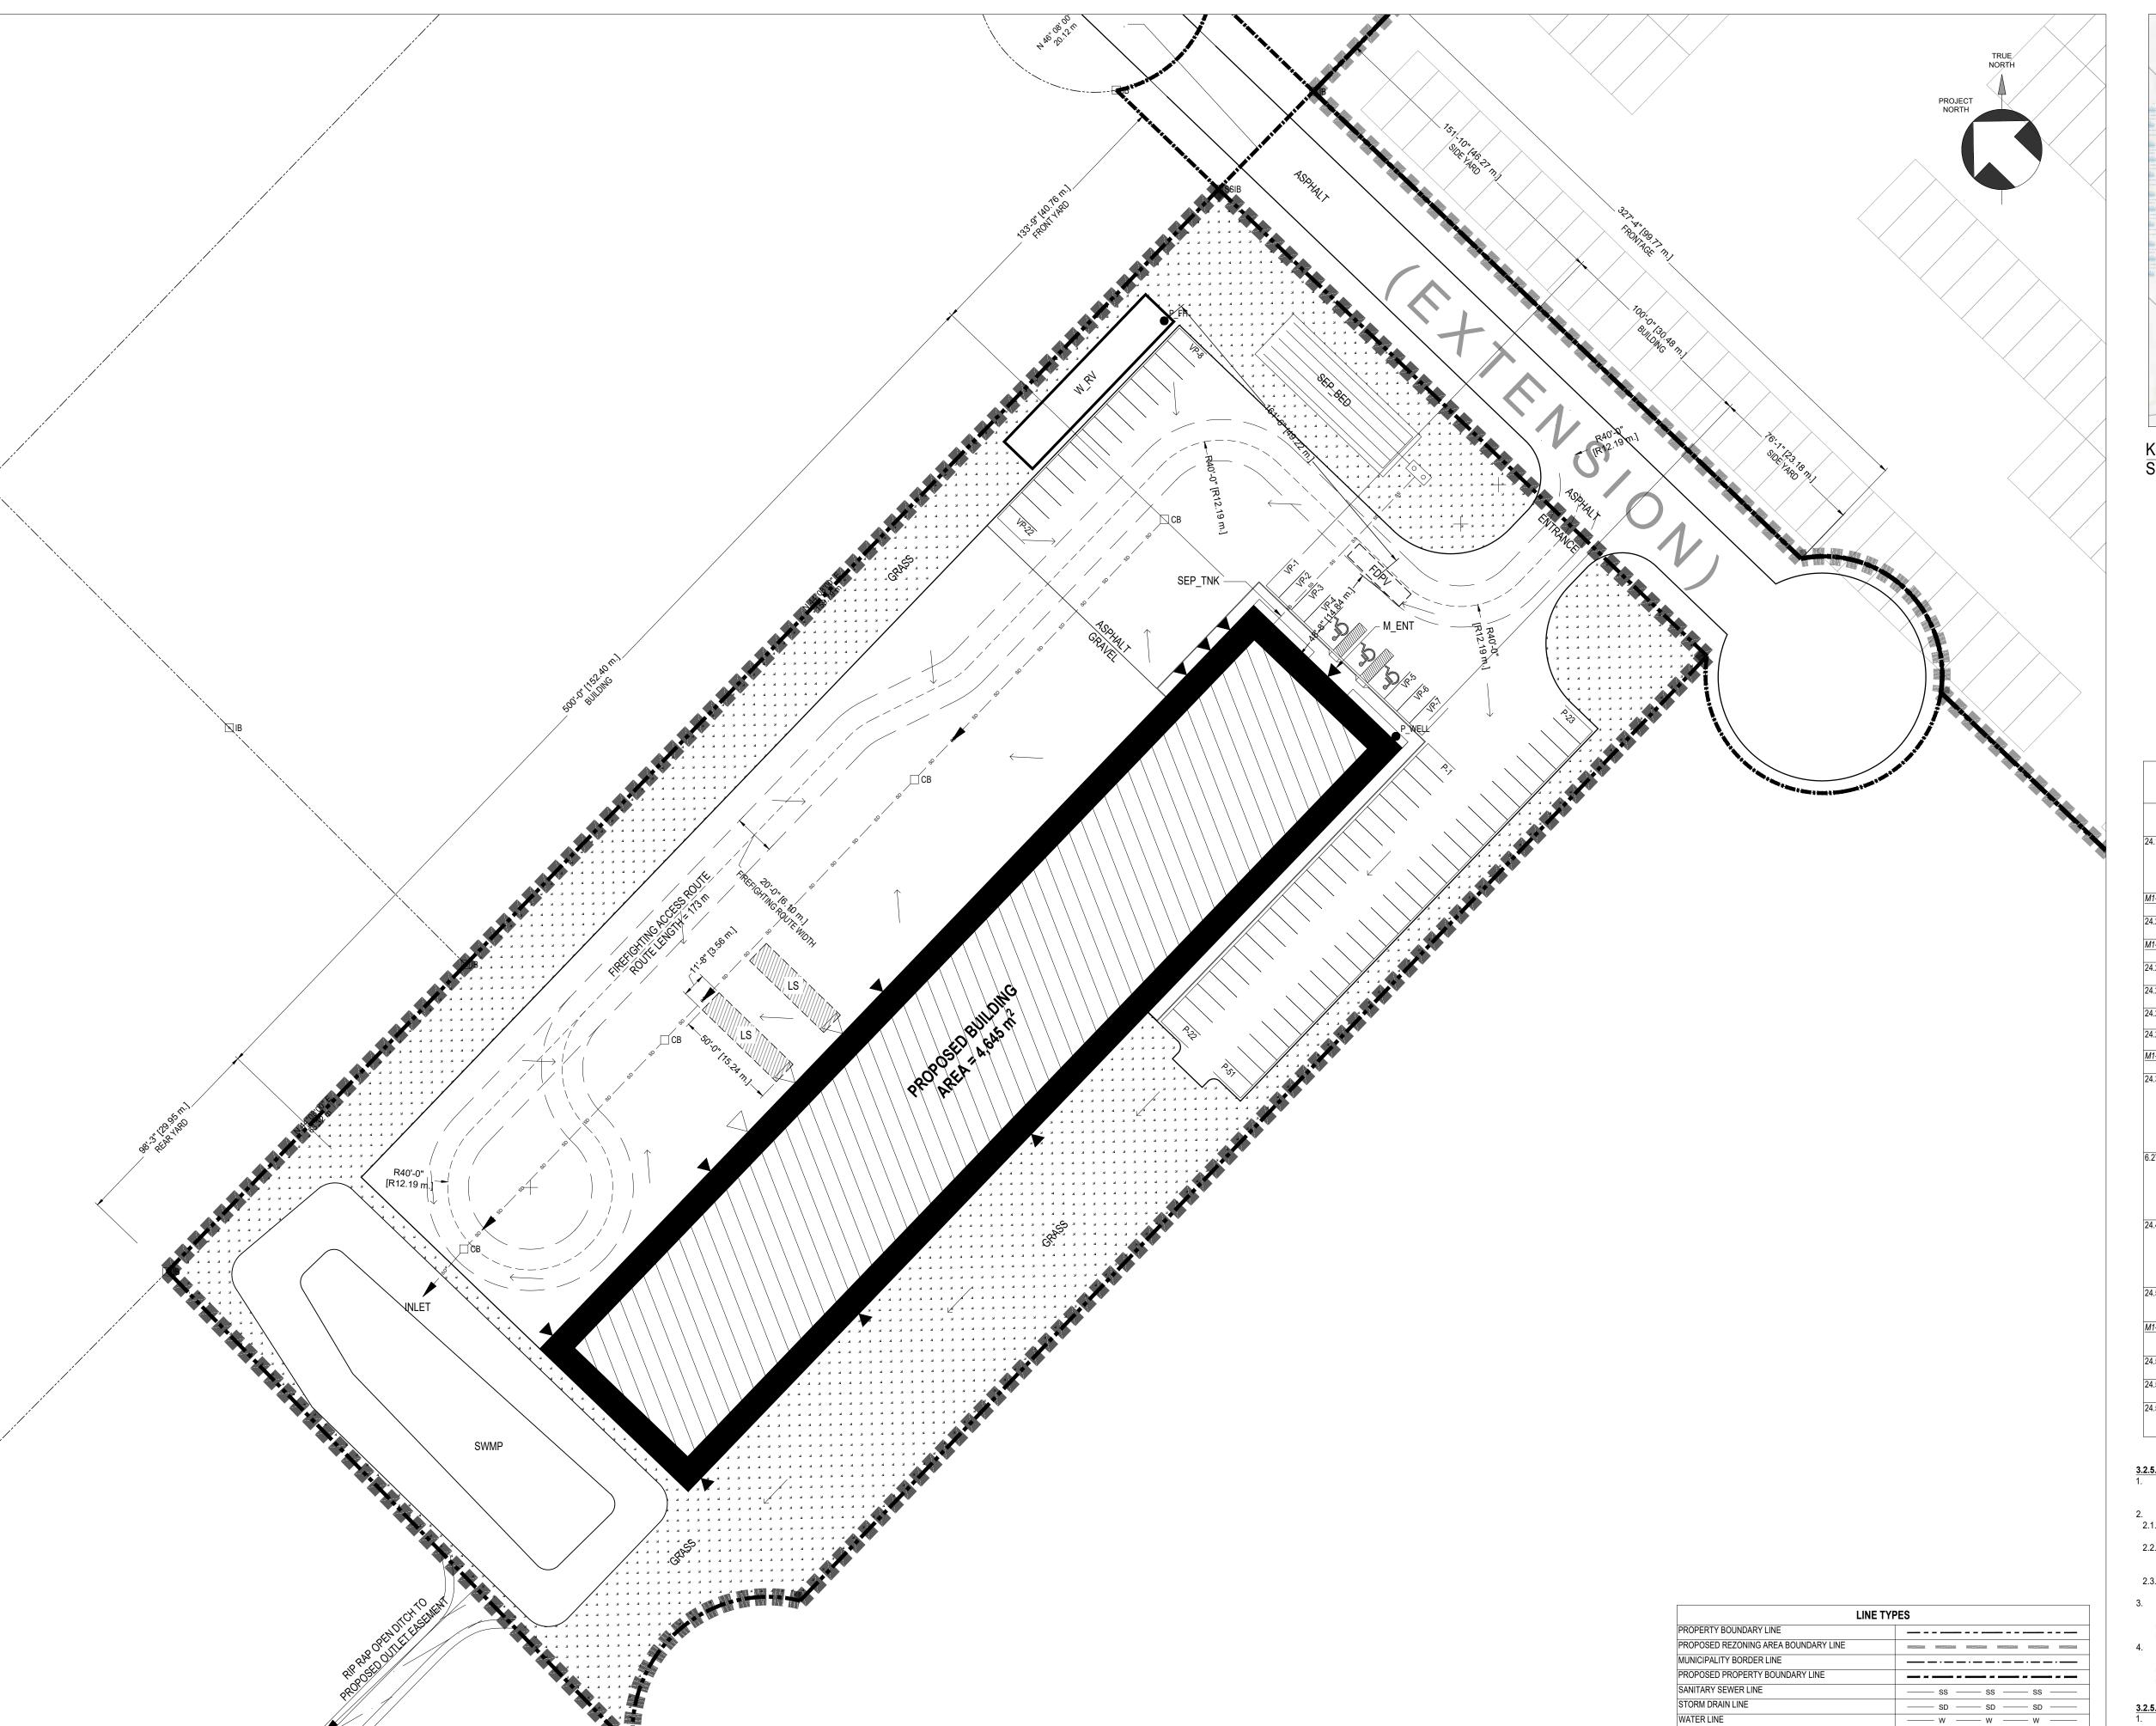

YARDISTRY SITE PLAN

SCALE 1"=40'



KEY PLAN SCALE 1" = 600'

LEGEND				
DESCRIPTION	TAG	DESCRIPTION	TAG	
OVERHEAD DOOR		WATER RESERVOIR	W_R\	
EGRESS DOOR	V	FIRE DEPARTMENT PUMPER VEHICLE	FDPV	
IRON BAR	■ IB	GRASS	* * *	
SHORT STANDARD IRON BAR	■ SSIB	MAIN ENTRANCE	M_ENT	
STANDARD IRON BAR	■ SIB	PARKING SPOT	P-#	
CATCH BASIN	СВ	VISITORS PARKING SPOT	VP-#	
MAN HOLE	ШМН	BARRIER FREE PARKING SPOT	Ł.	
PROPOSED FIRE HYDRANT	● P_FH	SEPTIC TANK	SEP_TN	
PROPOSED WELL	● P_WELL	OIL AND GREASE TRAP	OGT	
STORM POND	SWMP	SEPTIC BED	SEP_BE	
HYDRO POLE	○HP	SIGN	Q	
LOADING SPACE	LS	LIGHT POLE	● LP	

	SECTION 24 - M1-237 - INDUSTRIAL ZONE (MUNICIPALITY OF WEST GREY ZONING BY-LAW 37-2006)				
	DESCRIPTION	MINIMUM/MAXIMUM ZONING REQUIREMENTS	PROVIDED		
24.1	PERMITTED USES	Any manufacturing, processing, assembly, repair, fabricating, milling except for a motor vehicle recycling and salvage or wrecking facility, junk or scrap yard, fertilizer manufacturer, abattoir, rendering plant or any use considered offensive by the Public Health Act	COMPLIES		
M1-237	LOT AREA, MINIMUM	0.8 ha	2.23 ha		
24.2.2	LOT FRONTAGE, MINIMUM	20 m (65.6 ft)	99.77 m		
M1-237	FRONT YARD, MINIMUM	15 metres	40.76 m		
24.2.4	INTERIOR SIDE YARD, MINIMUM	3 m (9.8 ft); 9.2 m (30.2 ft) where an M1 Zone abuts any residential zone.	SOUTH 23.18 m NORTH 46.27 m		
24.2.5	EXTERIOR SIDE YARD, MINIMUM	7.5 m (24.6 ft)	N/A		
24.2.6	REAR YARD, MINIMUM	7.5 m (24.6 ft); 9.2 m (30.2 ft) where an M1 Zone abuts any residential zone.	29.95 m		
24.2.7	LOT COVERAGE, MAXIMUM	60%	20.83% (4,645 m ²)		
M1-237	BUILDING HEIGHT, MAXIMUM	15 metres	9.2 m		
24.3	PARKING SPACE REGULATION - VISITOR				
6.27	PARKING REGULATIONS	6.27.1 Size of Parking Spaces 6.27.2 Access to Parking Spaces 6.27.3 Parking Surfaces 6.27.4 Location of Parking Areas and Spaces 6.27.5 Barrier Free Parking 6.27.8 Calculation of Parking Regulations	COMPLIES COMPLIES COMPLIES COMPLIES 3 SPACES 51 SPACES		
24.4			N/A		
24.5 (a)	OTHER PROVISIONS - a)	A Buffer Area/Strips shall be required where a M1Zone directly abuts any Residential Zone subject to the applicable regulations of Section 6.3 of this By-law.	N/A		
	MINIMUM LANDSCAPED OPEN SPACE	10%	47.13% (11,924 m ²)		
24.5 (b)	OTHER PROVISIONS - b)	Loading requirements shall be in accordance with the applicable regulations of Section 6.16 of this By-law.	2 LOADING SPACES		
24.5 (c)	,	Outdoor storage areas shall be in accordance with the applicable regulations Section 6.26 of this By-law.	COMPLIES		
24.5 (d)	OTHER PROVISIONS - d)	Garbage Storage Areas shall be provided in accordance with the applicable regulations of Section 6.11 of this By-law.	COMPLIES		

3.2.5.5. LOCATION OF ACCESS ROUTES

- Access routes for firefighting shall be located so that the principal entrance is located not less than 3 m (9'-10") and not more than 15 m (49'-3") from the closest portion of the access route required for fire department use, measured horizontally from the face of the building.
- Access routes shall be provided to a building so that,
 for a building provided with a fire department connection, a fire department pumper vehicle can be located adjacent to the hydrants referred to in Article 3.2.5.16., 2.b.
- for a building not provided with a fire department connection, a fire department pumper vehicle can be located so that the length of the access route from a hydrant to the vehicle plus the unobstructed path of travel for the firefighter from the vehicle to the building is not more than 90 m (295'-3"), and
 2.3. the unobstructed path of travel for the firefighter from the vehicle to the building is not more than 45 m
- The unobstructed path of travel for the firefighter required by Sentence (2) from the vehicle to the building shall be measured from the vehicle to the fire department connection provided for the building, except that if no fire department connection is provided, the path of travel shall be measured to the principal entrance of the building.
 If a portion of a building is completely cut off from the remainder of the building so that there is no access to
- 4. If a portion of a building is completely cut off from the remainder of the building so that there is no access to the remainder of the building, the access routes required by Sentence (2) shall be located so that the unobstructed path of travel from the vehicle to one entrance of each portion of the building is not more than 45 m (147'-8")

3.2.5.6 ACCESS ROUTE DESIGN

1.7.be connected with a public thoroughfare.

A portion of a roadway or yard provided as a required access route for fire department use shall,
 1.1.have a clear width not less than 6 m, unless it can be shown that lesser widths are satisfactory,
 1.2.have a centreline radius not less than 12 m,

1.3.have an overhead clearance not less than 5 m,
1.4.have a change of gradient not more than 1 in 12.5 over a minimum distance of 15 m,
1.5.be designed to support the expected loads imposed by firefighting equipment and be surfaced with concrete,asphalt or other material designed to permit accessibility under all climatic conditions,
1.6.have turnaround facilities for any dead-end portion of the access route more than 90 m long, and

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H.BYE TIMERING
MOUNT FOREST
519-323-1527
Since 2017

H.BYE

CONSTRUCTION BY:

H.BYE

PROJECT NAME / LOCATION:


VIKING & YARDISTRY

DEVELOPMENT

OWNER:

SHEET TITLE:
YARDISTRY SITE PLAN



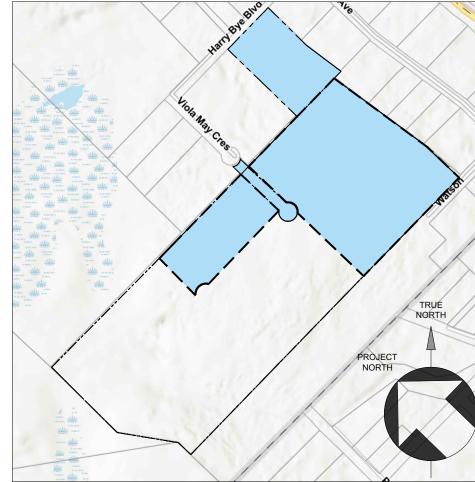

KEY PLAN SCALE 1" = 600'



SVCA SCREENING KEY PLAN SCALE 1" = 600'

		DRAWI	NG REVISIONS		
No.	DATE		REVISION	BY	APPVD
		DRAW	ING RELEASE		
DAT	Έ	ISSUE		BY	APPVD
ENG	SINEER	:			
11.57/5					

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VIKING & YARDISTRY DEVELOPMENT

SHEET TITLE: ENVIRONMENTAL OFFSETS AND

CONSTRUCTION BY:

PROJECT NAME / LOCATION:


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			E	MGINEERING MOUNT FOREST 519-323-1527 Since 2017
LEGEND		S	014/1/55	
IRON BAR	□ ІВ	AWING	OWNER:	
SHORT STANDARD IRON BAR	☐ SSIB	 		H.BYE

	I		
	IRON BAR	□ ІВ	
	SHORT STANDARD IRON BAR	☐ SSIB	
	STANDARD IRON BAR	☐ SIB	
LINE	TYPES		
PROPERTY BOUNDARY LINE			
PROPOSED REZONING AREA BOUNDARY LINE			
MUNICIPALITY BORDER LINE			
PROPOSED PROPERTY BOUNDARY LINE			
TREE DRIP LINE			
50m WOODLAND BUFFER			
SVCA SCREENING AREA			
10m CTODM DITCH OFFCFT			

LINE TYPES		
DUNDARY LINE		
EZONING AREA BOUNDARY LINE		
BORDER LINE		
ROPERTY BOUNDARY LINE		
NE		
ND BUFFER		
NING AREA		
ITCH OFFSET		
	1	

ENVIRONMENTAL SITE PLAN SCALE 1:1800

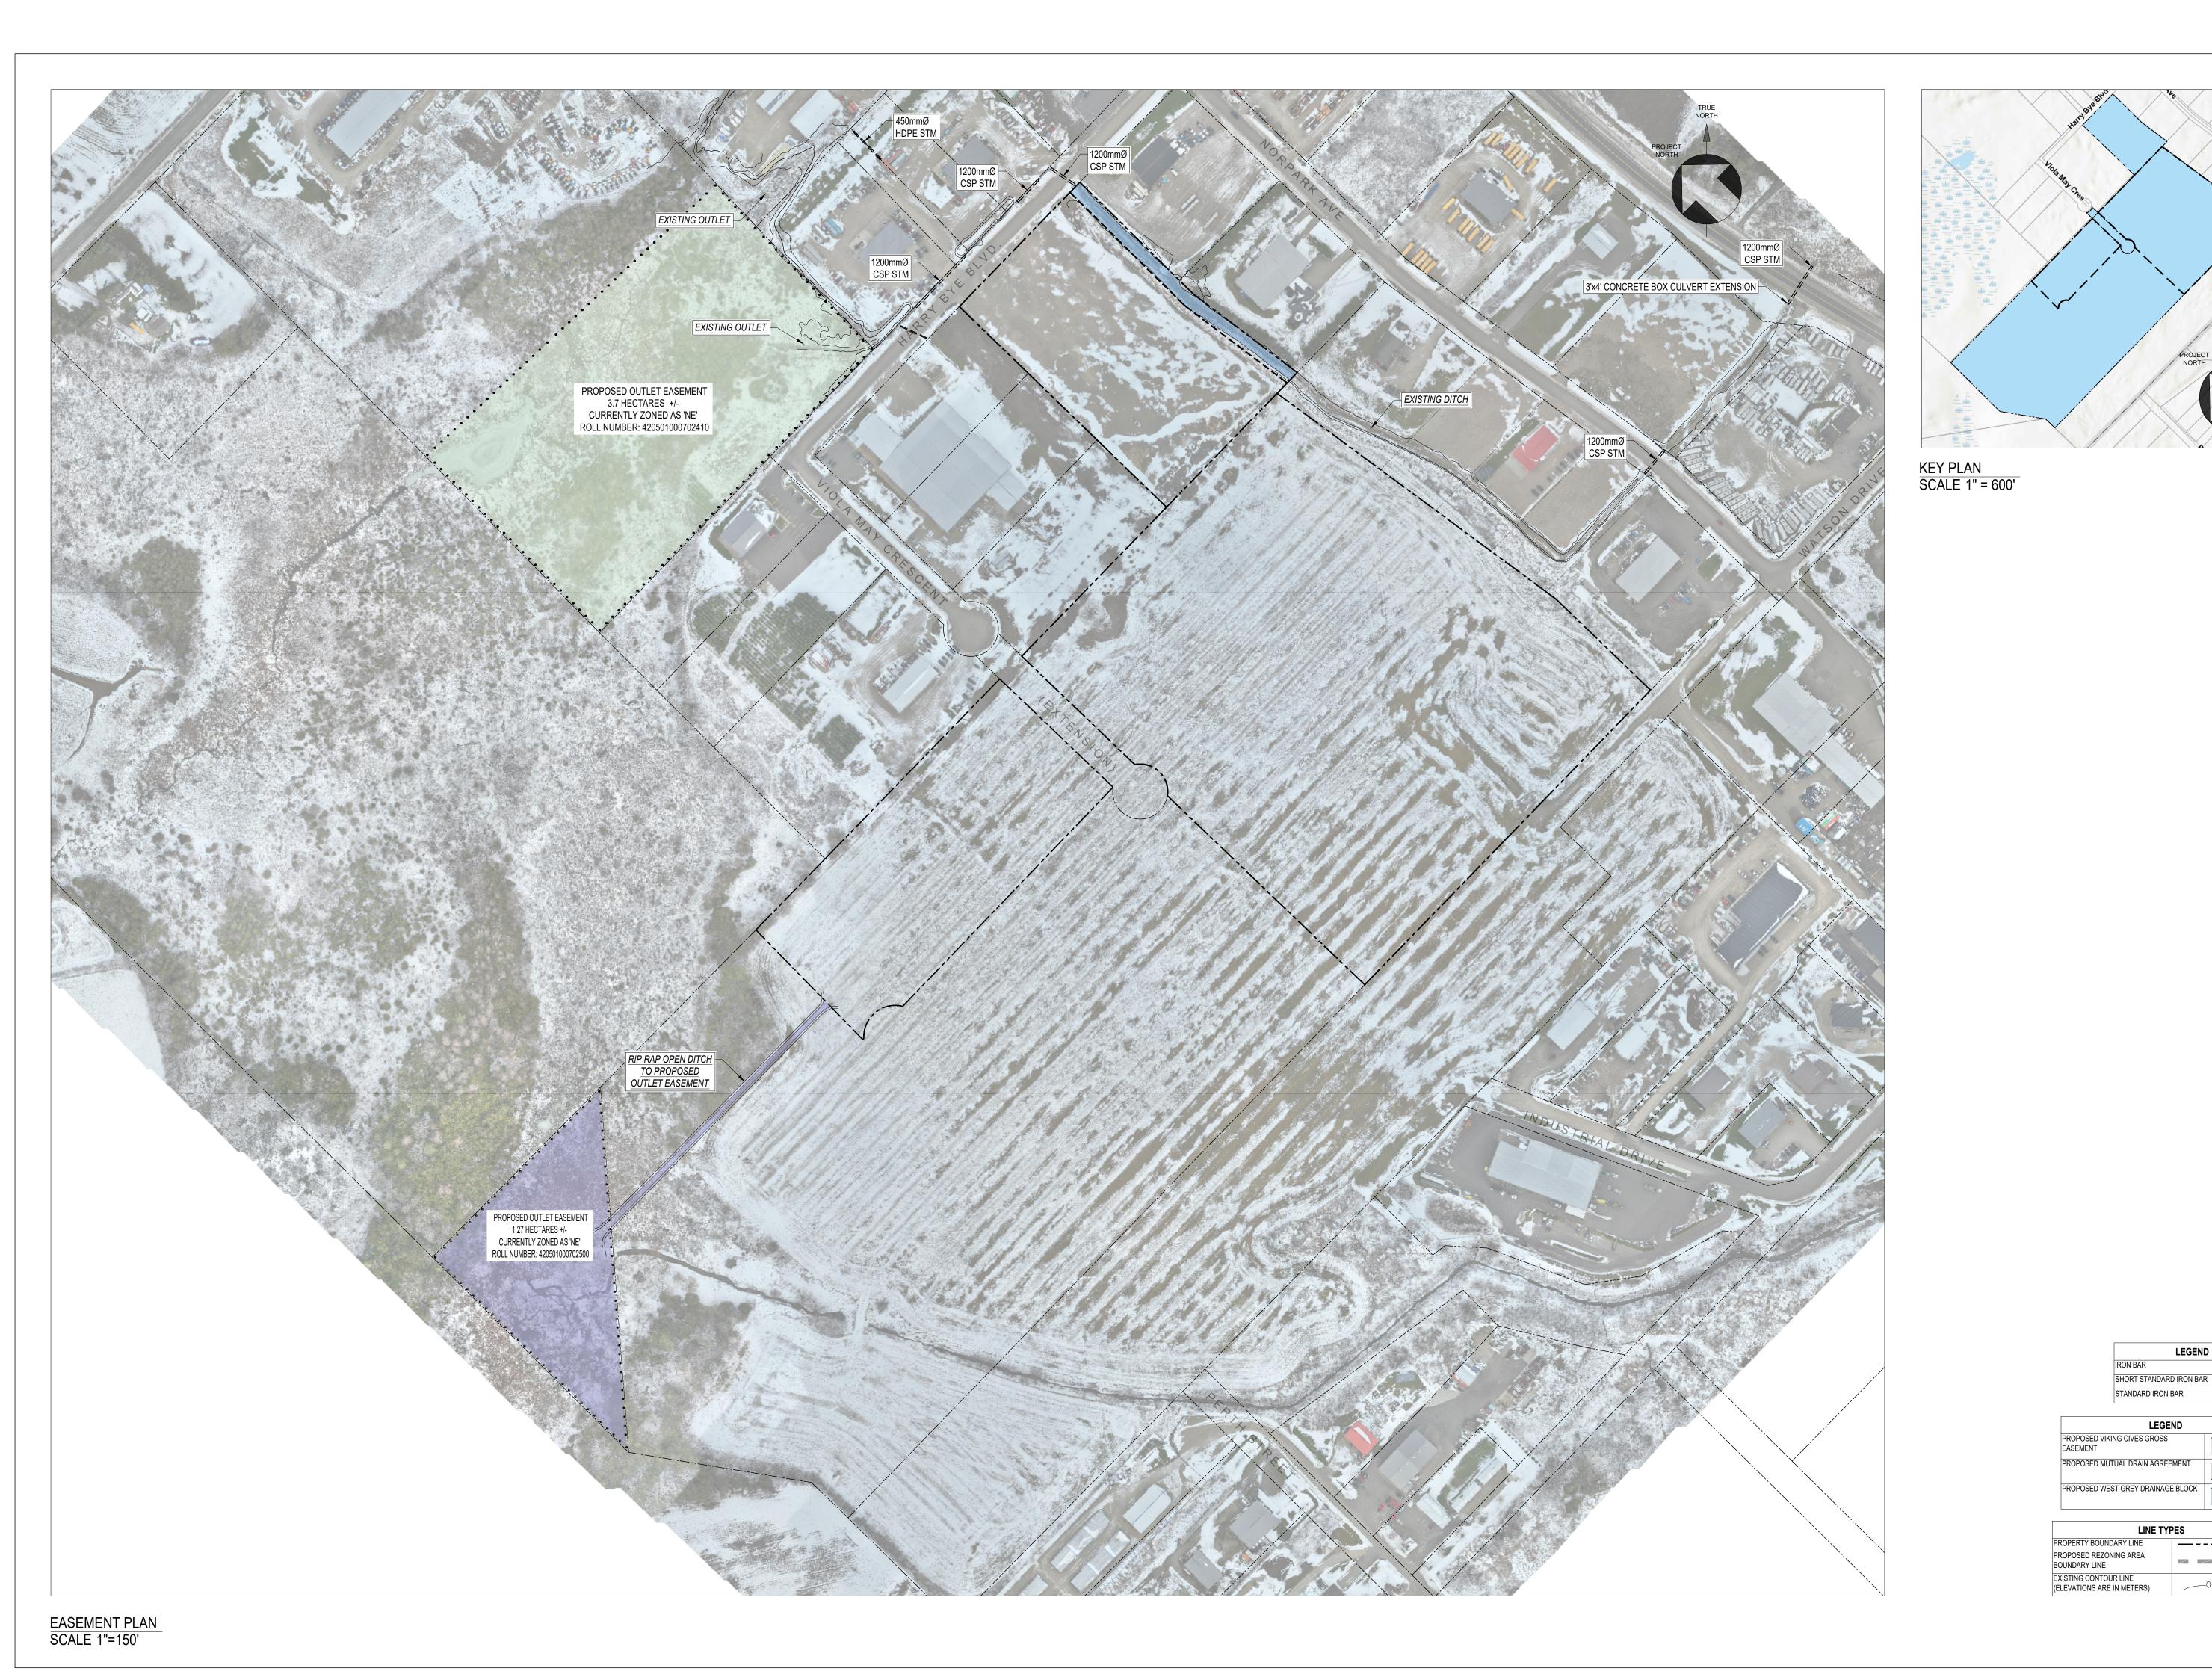

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Since 2017


OWNER: H.BYE CONSTRUCTION BY: H.BYE


PROJECT NAME / LOCATION: PROPERTY BOUNDARY LINE

SSIB SIB

LEGEND

VIKING & YARDISTRY DEVELOPMENT

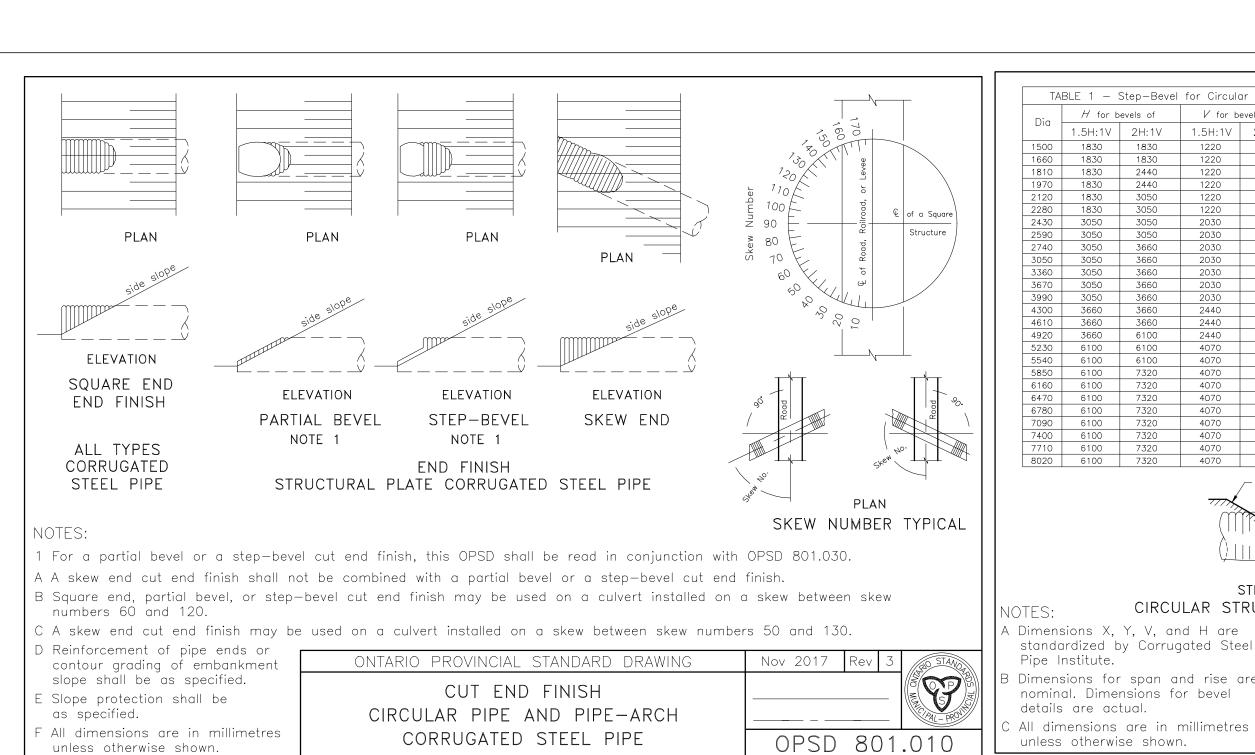

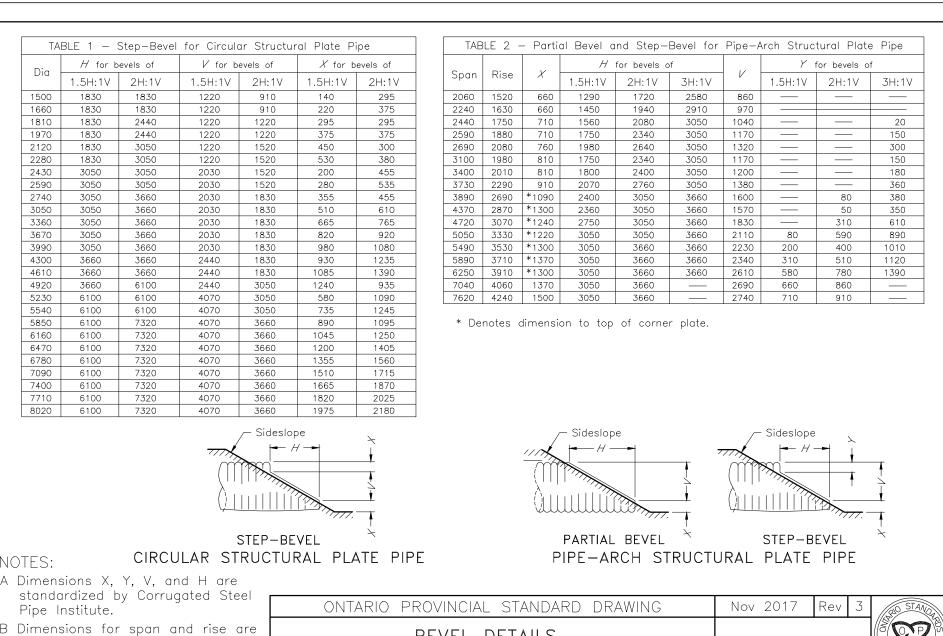



BEVEL DETAILS


CIRCULAR AND PIPE-ARCH


STRUCTURAL PLATE CORRUGATED STEEL PIPE


OPSD 801.030

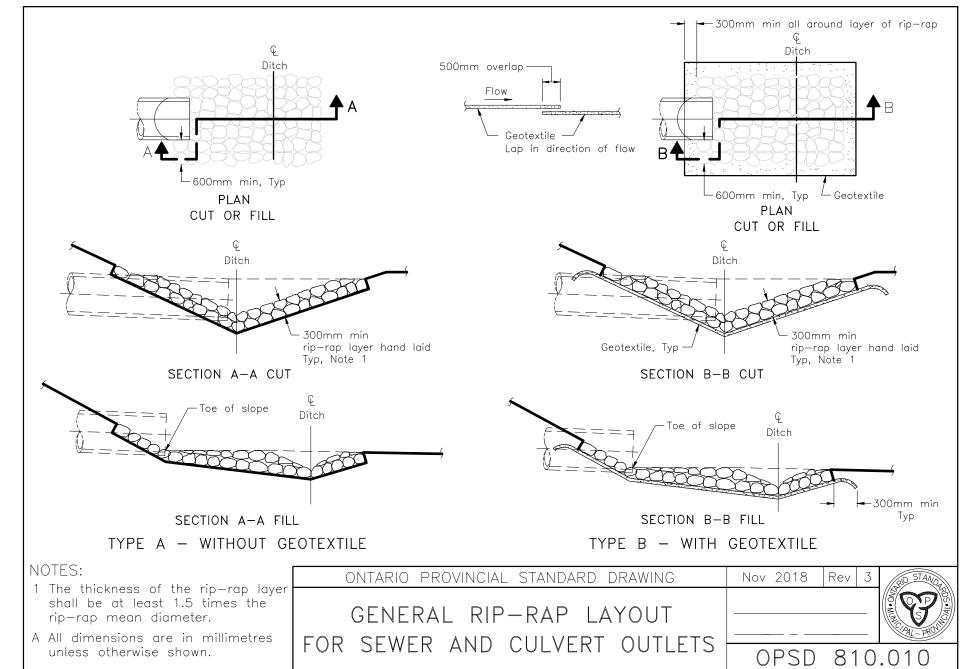

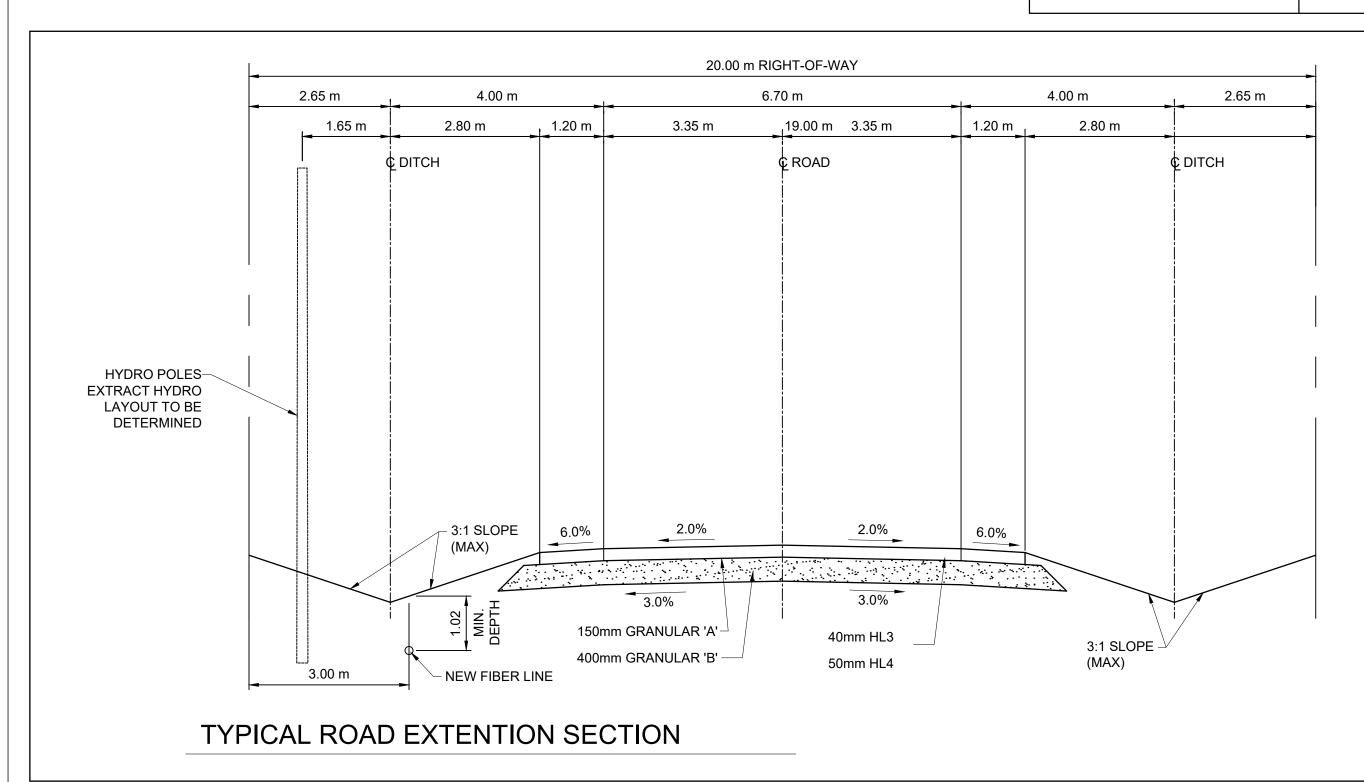


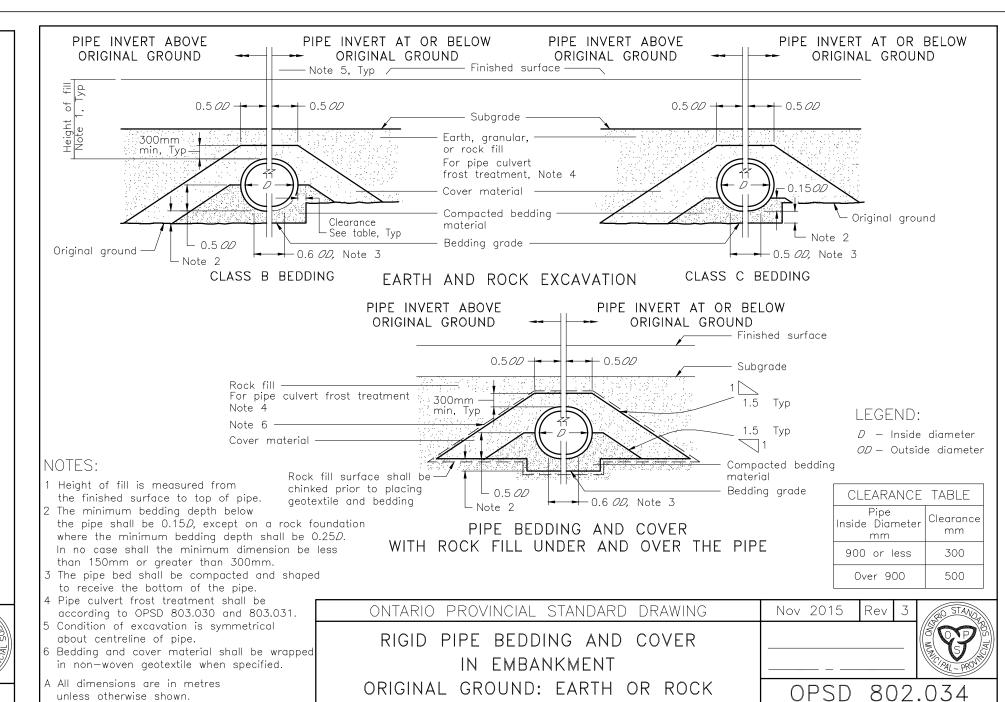

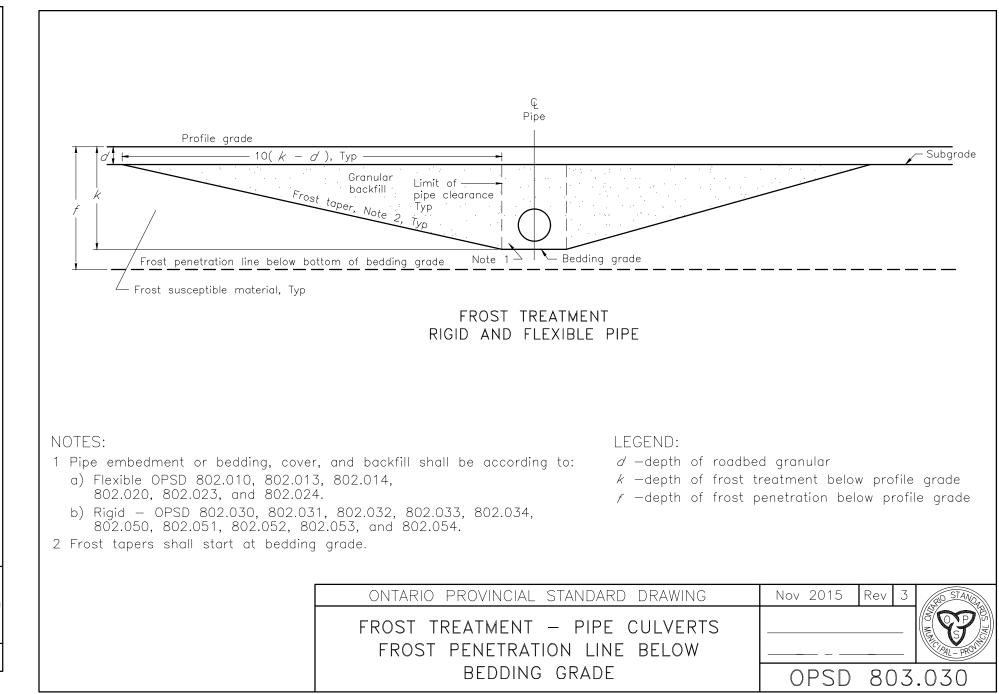

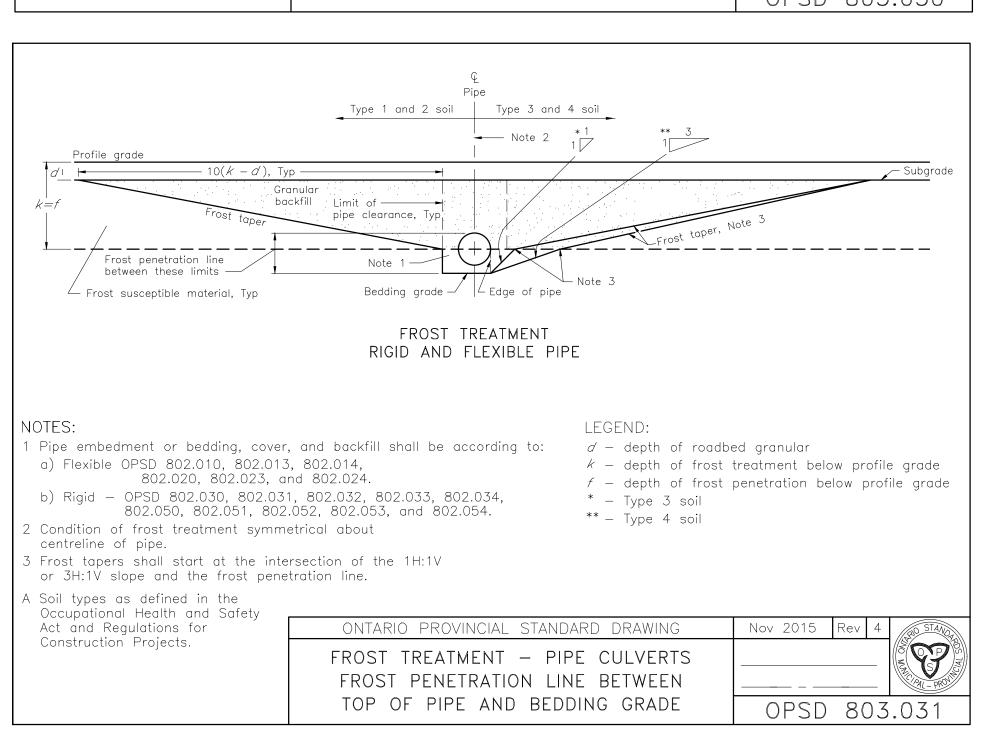

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VIKING & YARDISTRY

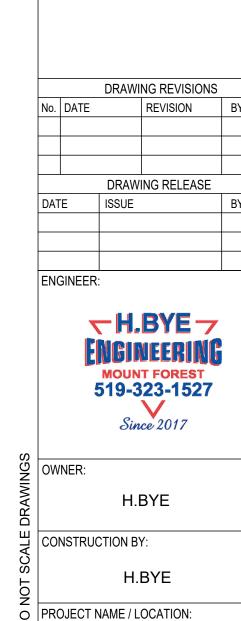DEVELOPMENT

DWG FILE: Viking Cives + Yardistry #14
DRAWN BY: R.M.M. JOB#: 20

SEPT. 9, 2025 AS NOTED

CHECKED BY: H.B.
REVISION: N/A

STANDARD DETAILS

SHEET TITLE: